

SEE DWG. A-3 FOR LIGHT FIXTURE LEGEND

Sheet 11 of 41



THE PORT AUTHORITY
OF NY & NJ

James J. Ambrose
Engineering Program Manager



No.	Date	Revision	Approved
3/15/01		Drawings of Record	

Engineering Department
Design Division

The World Trade
Center
Electrical/HVAC
Upgrade Program


Title
LOW VOLTAGE DISTRIBUTION
ONE WTC
ARCHITECTURAL
84TH FLOOR
NORTH & SOUTH SIDE
REFLECTED CEILING
PLANS & SECTION

This drawing subject to conditions in contract.
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herein are reserved to Port Authority and
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S.C.&M.S. S.C.&S.P.P.
Designed by Drawn by Checked by


Date 10-4-93 Scale AS NOTED

Contract Number Drawing Number
WTC-804.041 A-8

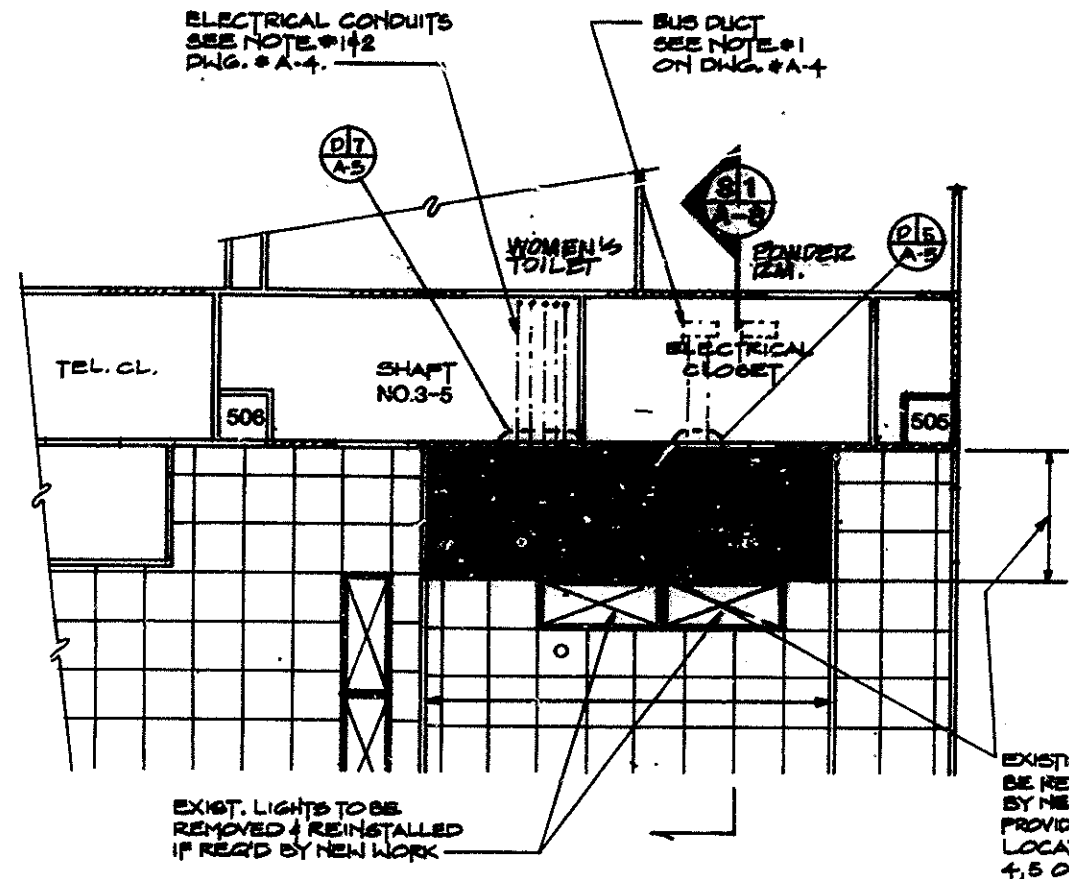


84 NORTH-REFLECTED CEILING PLAN

SCALE IN FEET

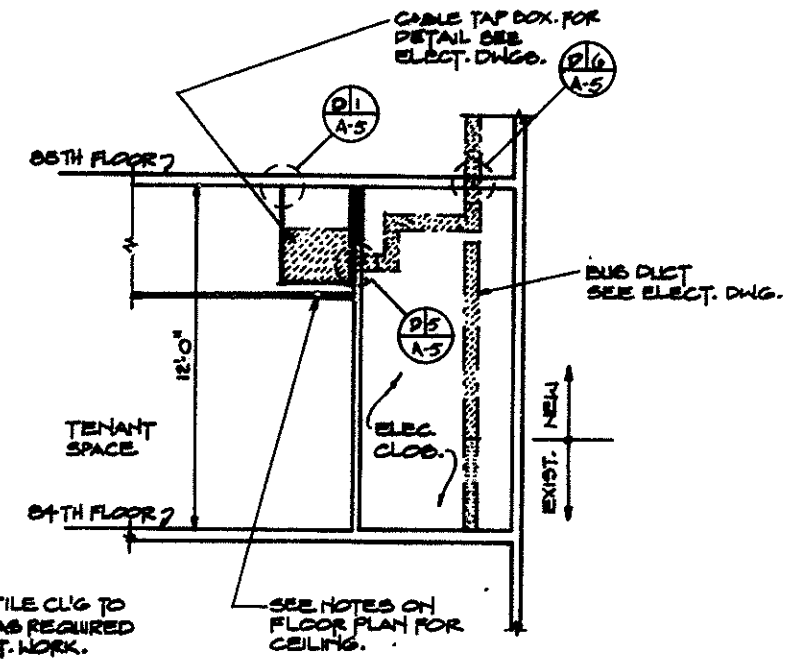


SECTION
S1
A-8

SCALE IN FEET

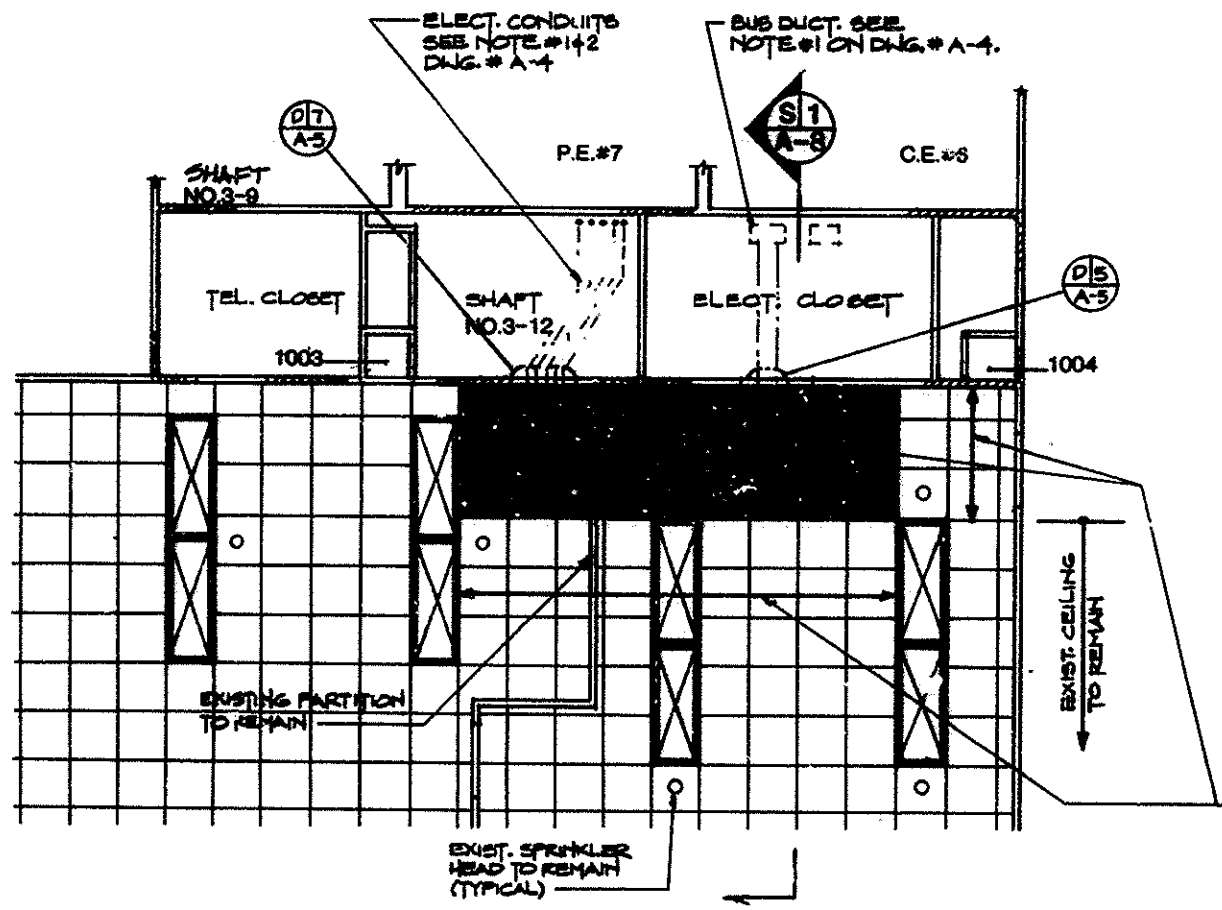

84 SOUTH-REFLECTED CEILING PLAN

SCALE IN FEET

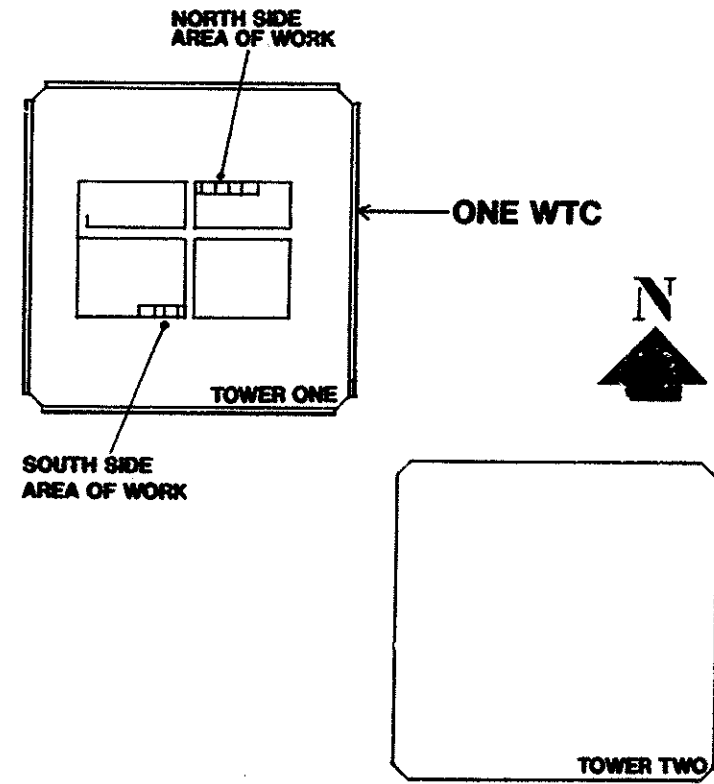

KEY PLAN
NO SCALE